PROPOSED 6 STORY RESIDENTIAL BUILDING WITH 5 RESIDENTIAL FLOORS OVER 1ST FLOOR PARKING AT:

366 6TH STREET,

BLOCK 9803, LOTS 9, JERSEY CITY HUDSON COUNTY, NEW JERSEY 07030

DF	RAMING LIST
Z-I	TITLE SHEET: KEY PLAN, VICINITY MAP AND ZONING TABULATION CHART
Z-2	EXISTING SITE PLAN AND PROPOSED SITE IMPACT PLAN
Z-3	SITE PLAN SHOWING UTILITIES AND UTILITY CONNECTION DETAILS
Z-4	SITE PLAN SHOWING LIGHTING, LANDSCAPING AND DETAILS
Z-5	IST FLOOR PLAN, 2ND THROUGH 6TH FLOOR PLAN(TYP) & DETAILED LAYOUTS(TYP)

Eighth Str

Seventh Str

Sixth Street

Mon

ROOF PLANS, TOP OF BULKHEAD PLAN AND ROOFING DETAILS

Z-9 SITE PHOTOS

Vinth Street

swick

hird Street

ZONING MAP SHOWING THE 1000' RADIUS AND THE 200' RADIUS

2,500 S.F. 345-45 D(2) LOT AREA (MIN.) LOT WIDTH (MIN.) 345-45 D(3) 345-46 D(4) LOT DEPTH (MIN.) 100 FT. 345-45 D(5) FRONT YARD SETBACK 5'-0" FT. AT 5TH FLOOR SIDE YARD SETBACK MIN. O FT. AT GROUND FLOOR I5 FT REAR YARD SETBACK MIN. 15 FT. AT IST TO 5TH FL 6 STORIES 345-45 D(8) BUILDING HEIGHT (MIN.) 3 STORIES 66'-0" 345-45 D(9) BUILDING HEIGHT (MAX.) 6 STORIES ABOVE GRADE MIN. FLOOR TO CEILING HGT FOR RESIDENTIAL FLOORS OFF STREET PARKING (MIN.) 20 SPACES 20 SPACES PROVIDED 345-45 E(f) REQUIRED SEE NOTE A 0.5 PARKING OFF STREET BICYCLE PARKING DWELLING UNITS SHALL PROVIDE ON SITE, MIN. OF I.O SPACES PER UNIT = 20 SPACES

ZONING TABULATIONS

NEIGHBORHOOD COMMERCIAL DISTRICT

PERMITTED USE

345-45 B(9)

IST FLOOR: = 7,500 SF = 6,375.00 SF 2ND FLOOR: = 6,375.00 SF 3RD FLOOR: = 6,375.00 SF 4TH FLOOR: = 6,375.00 SF 5TH FLOOR: 6TH FLOOR: = 6,000.00 SF TOTAL BUILDING AREA = 39,000.00 SF LOT COVERAGE 100% <u>UNIT BREAKDOWN</u>

BUILDING AREA:

PROPOSED

20 RESIDENTIAL UNITS ABOVE PARKING

RESIDENTIAL

ABOVE GROUND FLOOR

ZONE NO

ZONING TABULATION CHART

13 REGULAR PARKING 6 COMPACT PARKING

ONE AND TWO FAMILY HOUSING ONE AND TWO FAMILY HOUSING

MULTI-FAMILY ATTACHED HOUSING (4 STORIES

NEIGHBORHOOD COMMERCIAL

COMMERCIAL/AUTOMOTIVE

GOVERNMENT

INDUSTRIAL

PORT INDUSTRIAL

WATERFRONT PLANNED DEVELOPMENT

DESTINATION TOURISM

P/O PARKS/OPEN SPACE

NJMC NEW JERSEY MEADOWLANDS COMMISSION

REDEVELOPMENT PLAN AREAS


see top right panel for full listing.

OVERLAY DISTRICTS

///// HISTORIC DISTRICTS RESTAURANT OVERLAY ZONE


PALISADE PRESERVATION OVERLAY MARION WORKS OFFICE/RESIDENTIAL

//// SUBDISTRICT A //// SUBDISTRICT B

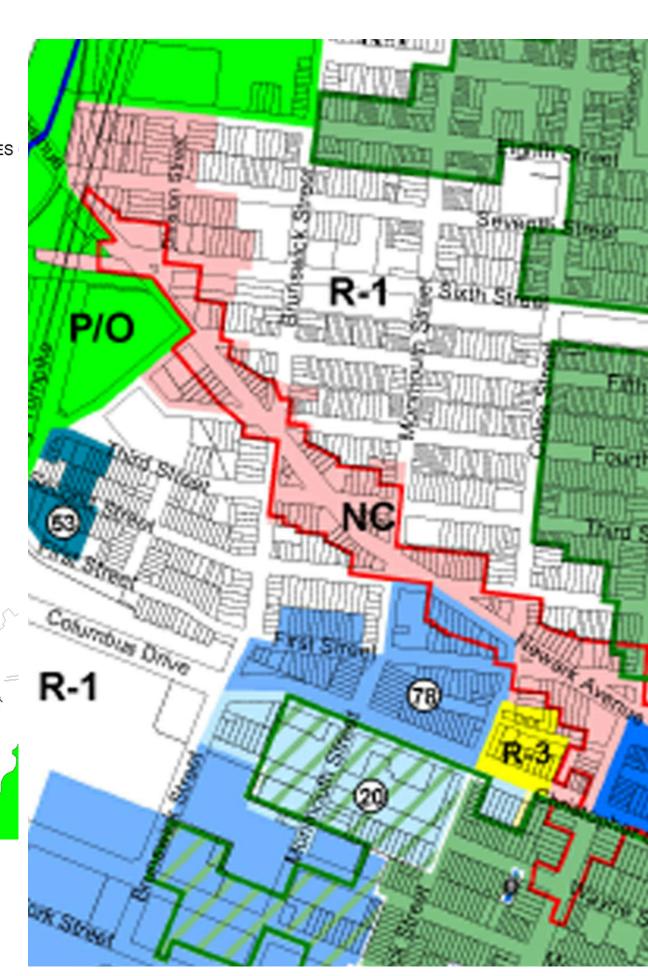

CHAIRMAN DATE SECRETARY DATE

THE APPLICANT WILL ADDRESS AND/OR COMPLY WITH THE COMMENTS OF THE JERSEY CITY REVIEW AGENTS

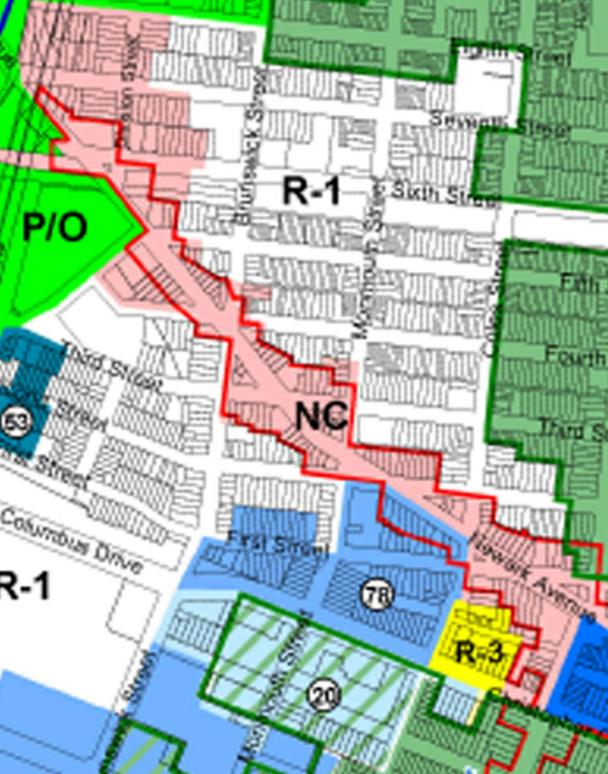

JERSEY CITY ZONING BOARD

ZONING BOARD APPROVAL

-ZONING TABULATION

SCALE = 1/128" = 1'-0"

Nohart.

Date

Minervini Vandermark

Architecture

Minervini Vandermark, LL0

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New Jersey, 07030

Frank J. Minervini, AIA

Anthony C. Vandermark AIA

NJ License # 12576

NY License # 32710-1

NY License # 03 0297 63

Applicant Kyle Enger

366 - 377 SIXTH STREET, JERSEY CITY.

BLOCK 9803

Sheet Title

CHART

TITLE SHEET: -KEY PLAN -VICINITY MAP

Project Description 6 STORY BUILDING WITH 5 RESIDENTIAL FLOORS OVER FIRST FLOOR PARKING


Project Number	:16-1299
Drawn by	: MJS
Checked by	: FJM, ACV
Scale	:As Noted


PROJECTED SANITARY SEWAGE FLOW


PROPOSED USE IS FOR 20 RESIDENTIAL UNITS (15) 2 BDRM UNITS WITH 5 PERSONS EA.x75 GPD/PERSON = 5,625 (5) 3 BDRM WITH 6 PERSONS EA.x75 GPD/PERSON = 2,250

TOTAL PROJECTED FLOW = 7,875 GPD (105 OCCUPANTS)

PROJECTED RECYCLING PLAN:				
	105 PERSONS			
GLASS	1.75 LBS X 105 = 183.75 LBS			
	105 LBS = 33 GAL. DRUM	2) 33 GALLON CONT.		
ALUMINUM	.I LBS X 105 = 10.5 LBS			
	74 LBS = I CUBIC YARD			
	= (I) 33 GAL. DRUM	(I) 33 GALLON CONT.		
TIN	1.5 LBS X 105 = 157.5 LBS			
	74 LBS = I CUBIC YARD			
	= (2) 33 GAL. DRUM	(2) 33 GALLON CONT.		
CARD BD.				
LE PAPER	105 BS = 33 GA DRUM	(3) 33 GALLON CONT		

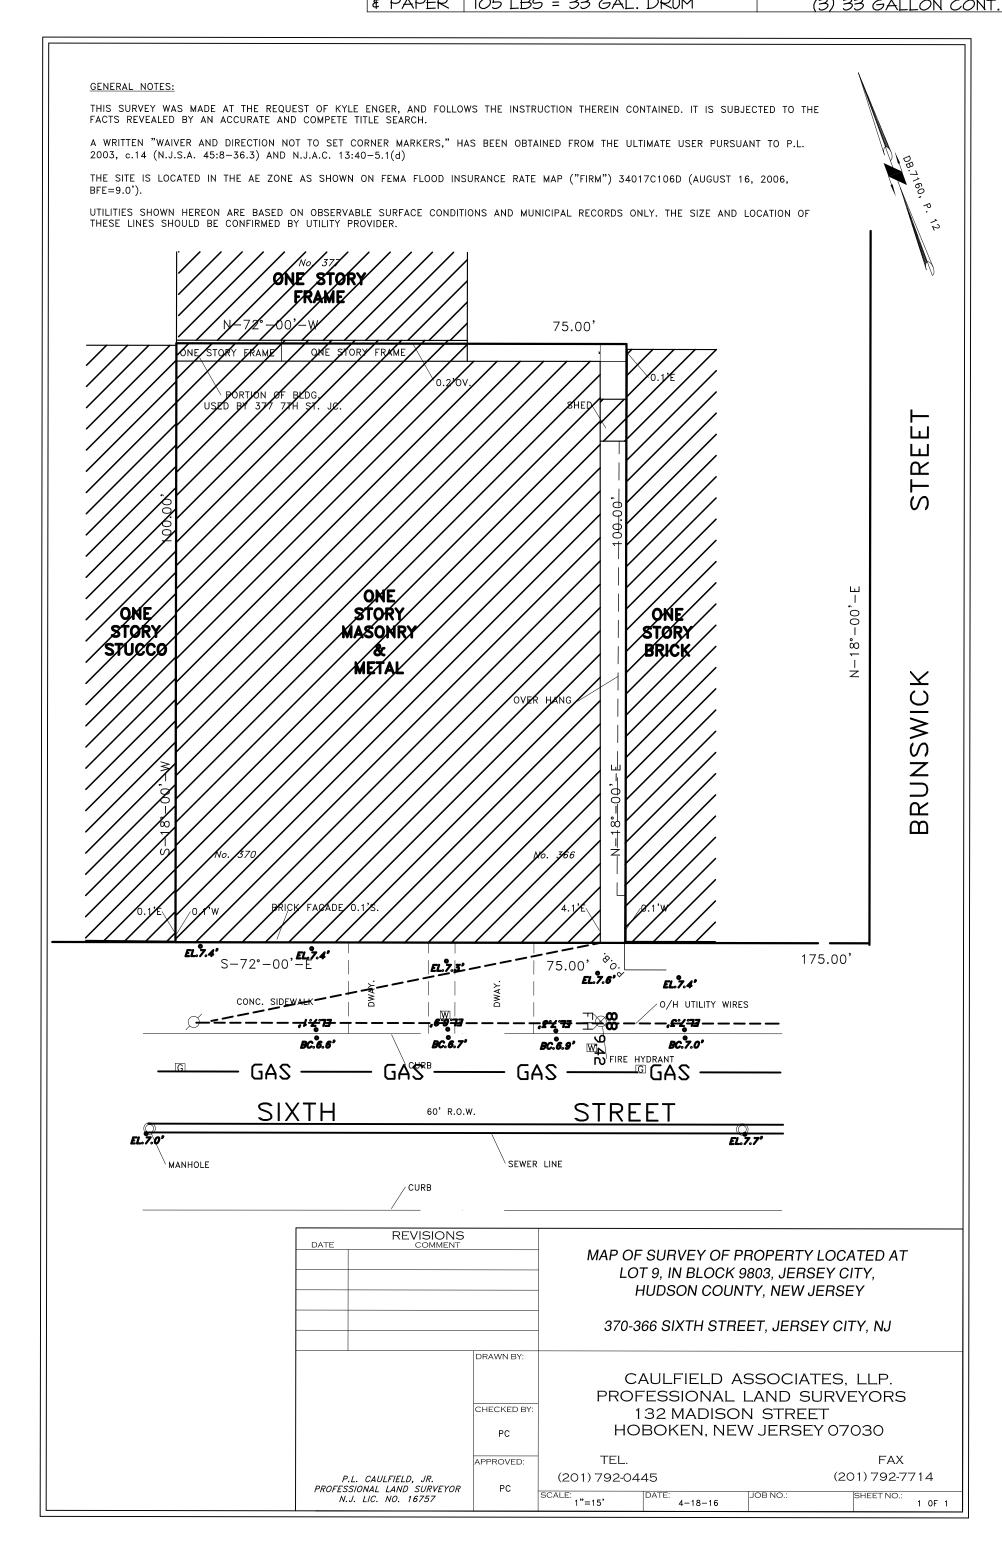

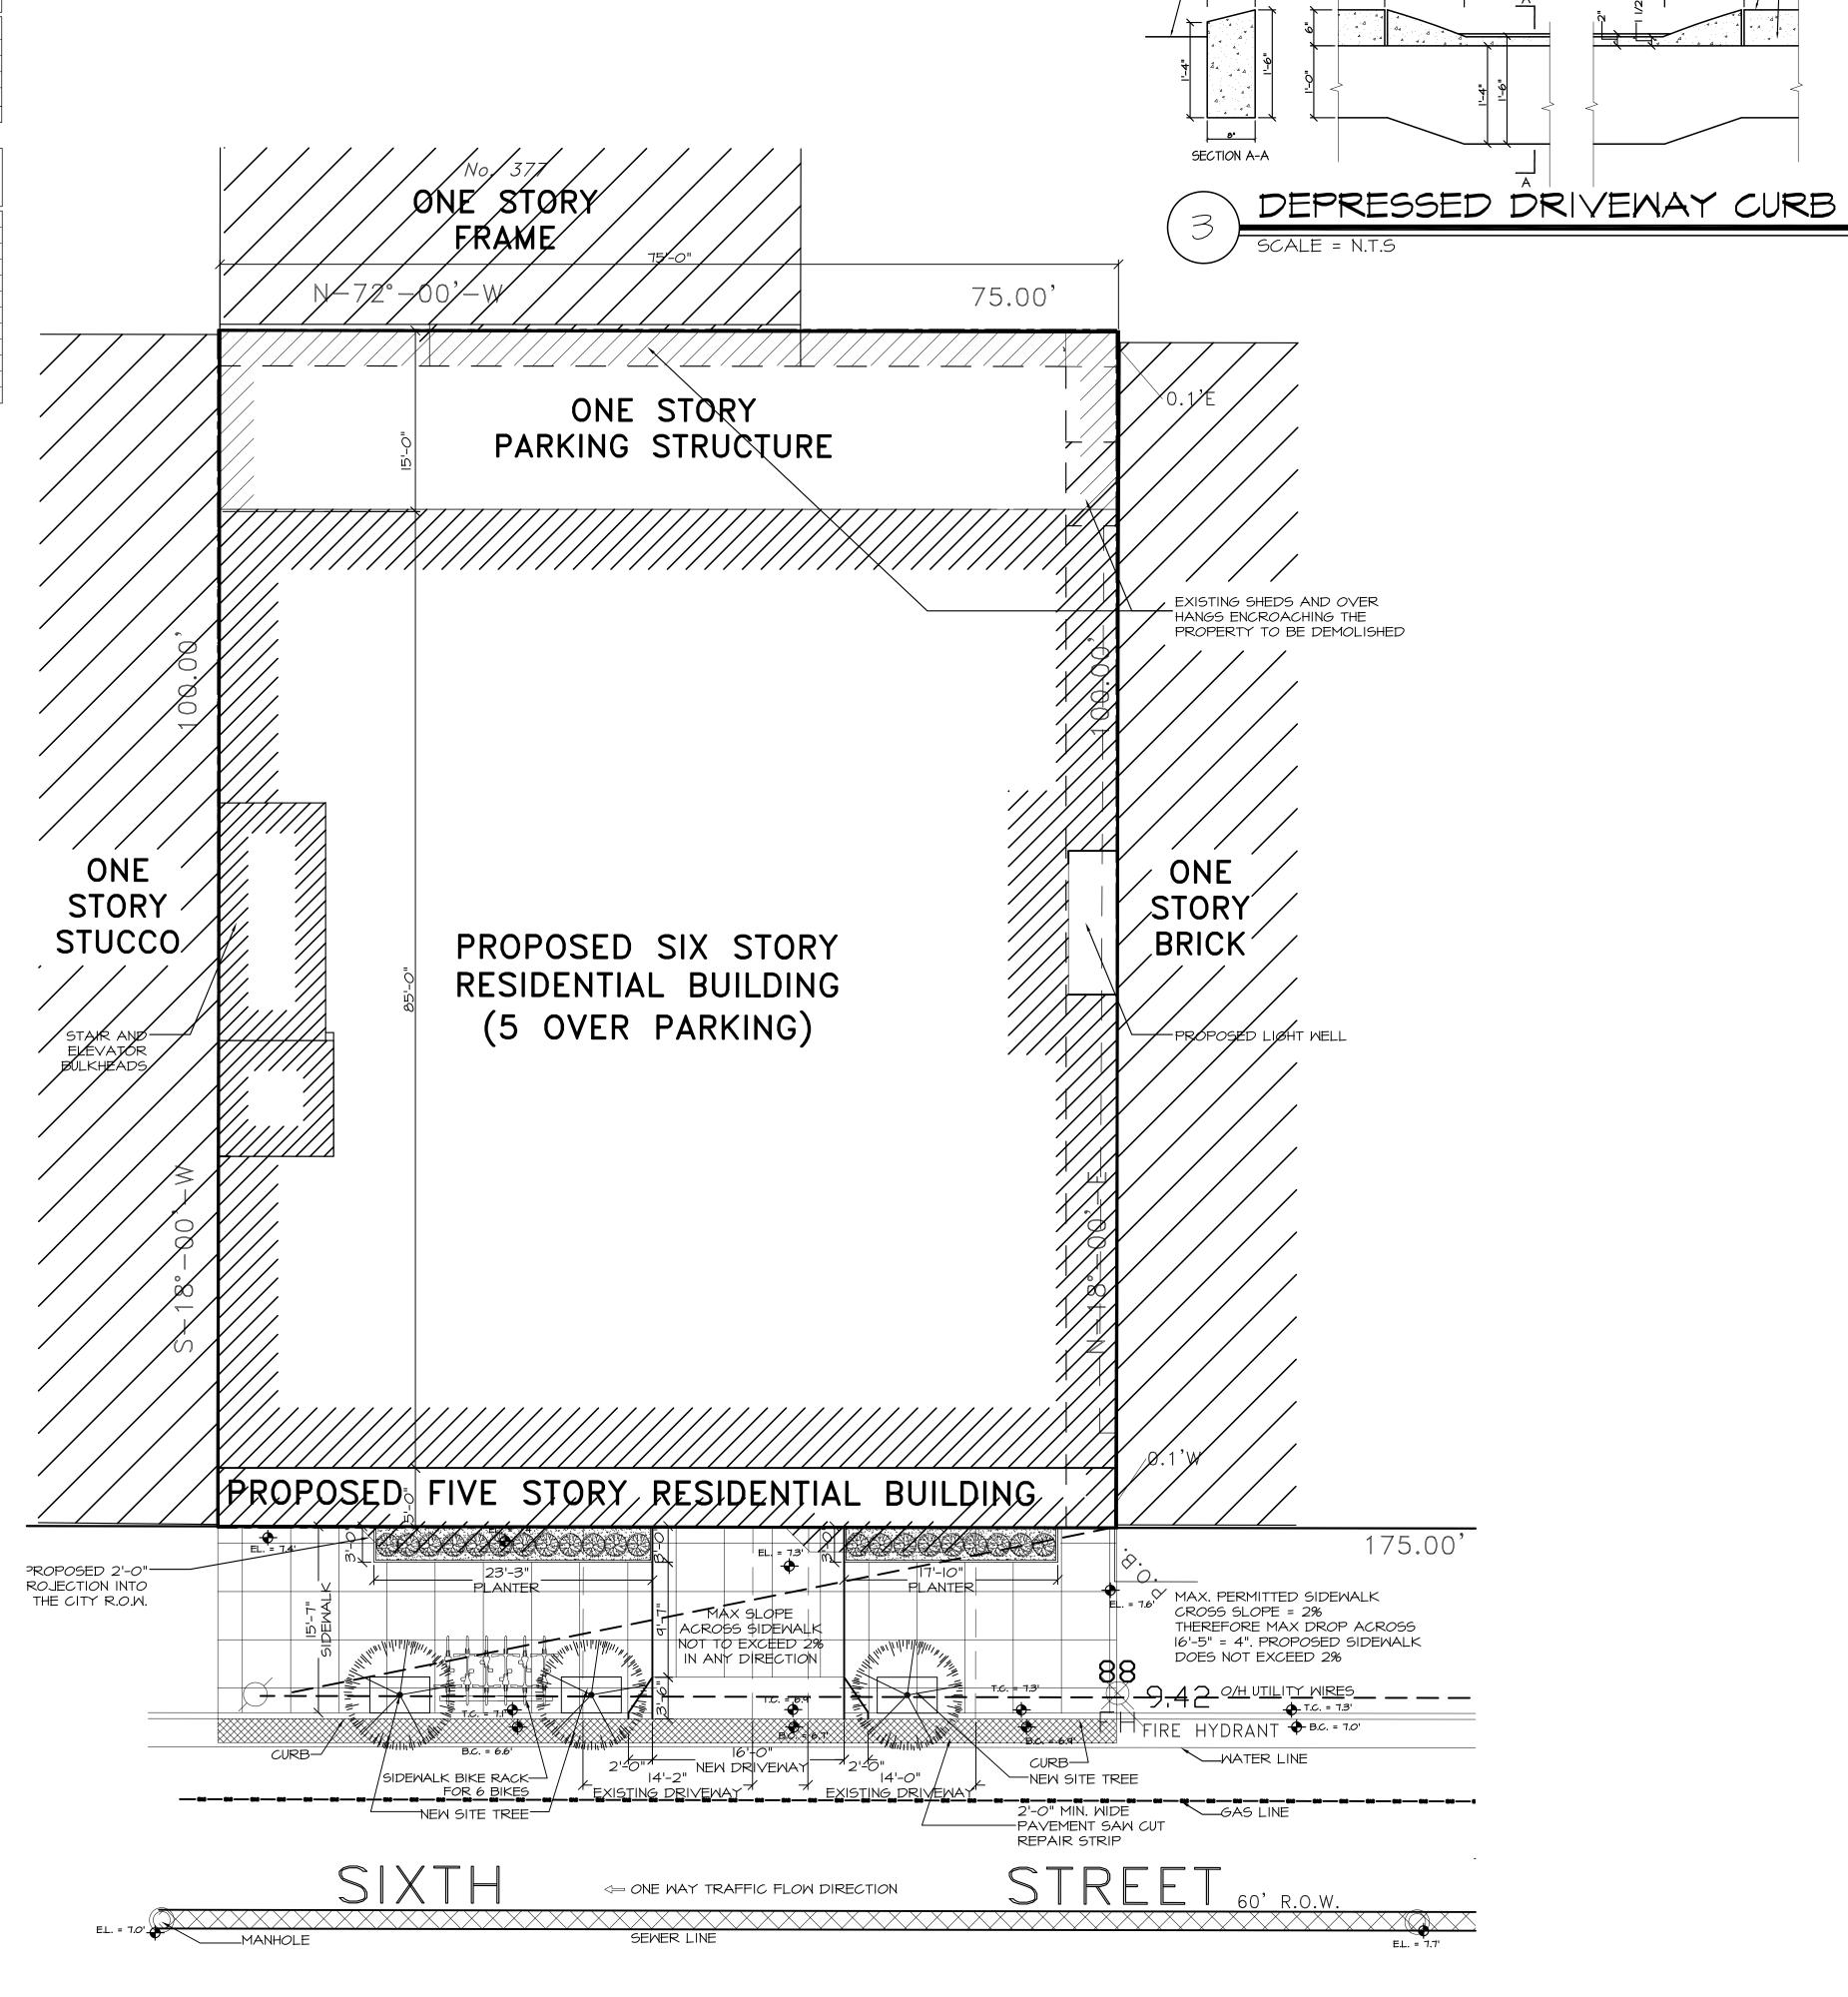

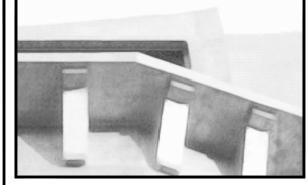

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PAVEMENT SURFACE

fax 201-386-0628

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Anthony C. Vandermark AIA NJ License # 17698 NY License # 32710-1

- | 11.10.16 | zoning resubmission - | 6.21.16 | ZONING # Date

Applicant Kyle Enger

366 - 377 SIXTH STREET, JERSEY CITY. BLOCK 9803

Project Description 6 STORY BUILDING WITH 5 RESIDENTIAL FLOORS OVER FIRST FLOOR PARKING

	Project Number	:16-1299
ı	Drawn by	: MJS
ı	Checked by	: FJM, ACV
ı	Scale	:As Noted

EXISTING SITE PLAN &


PROPOSED SITE IMPACT PLAN


EXISTING SITE PLAN



PROPOSED SITE IMPACT PLAN

CURB

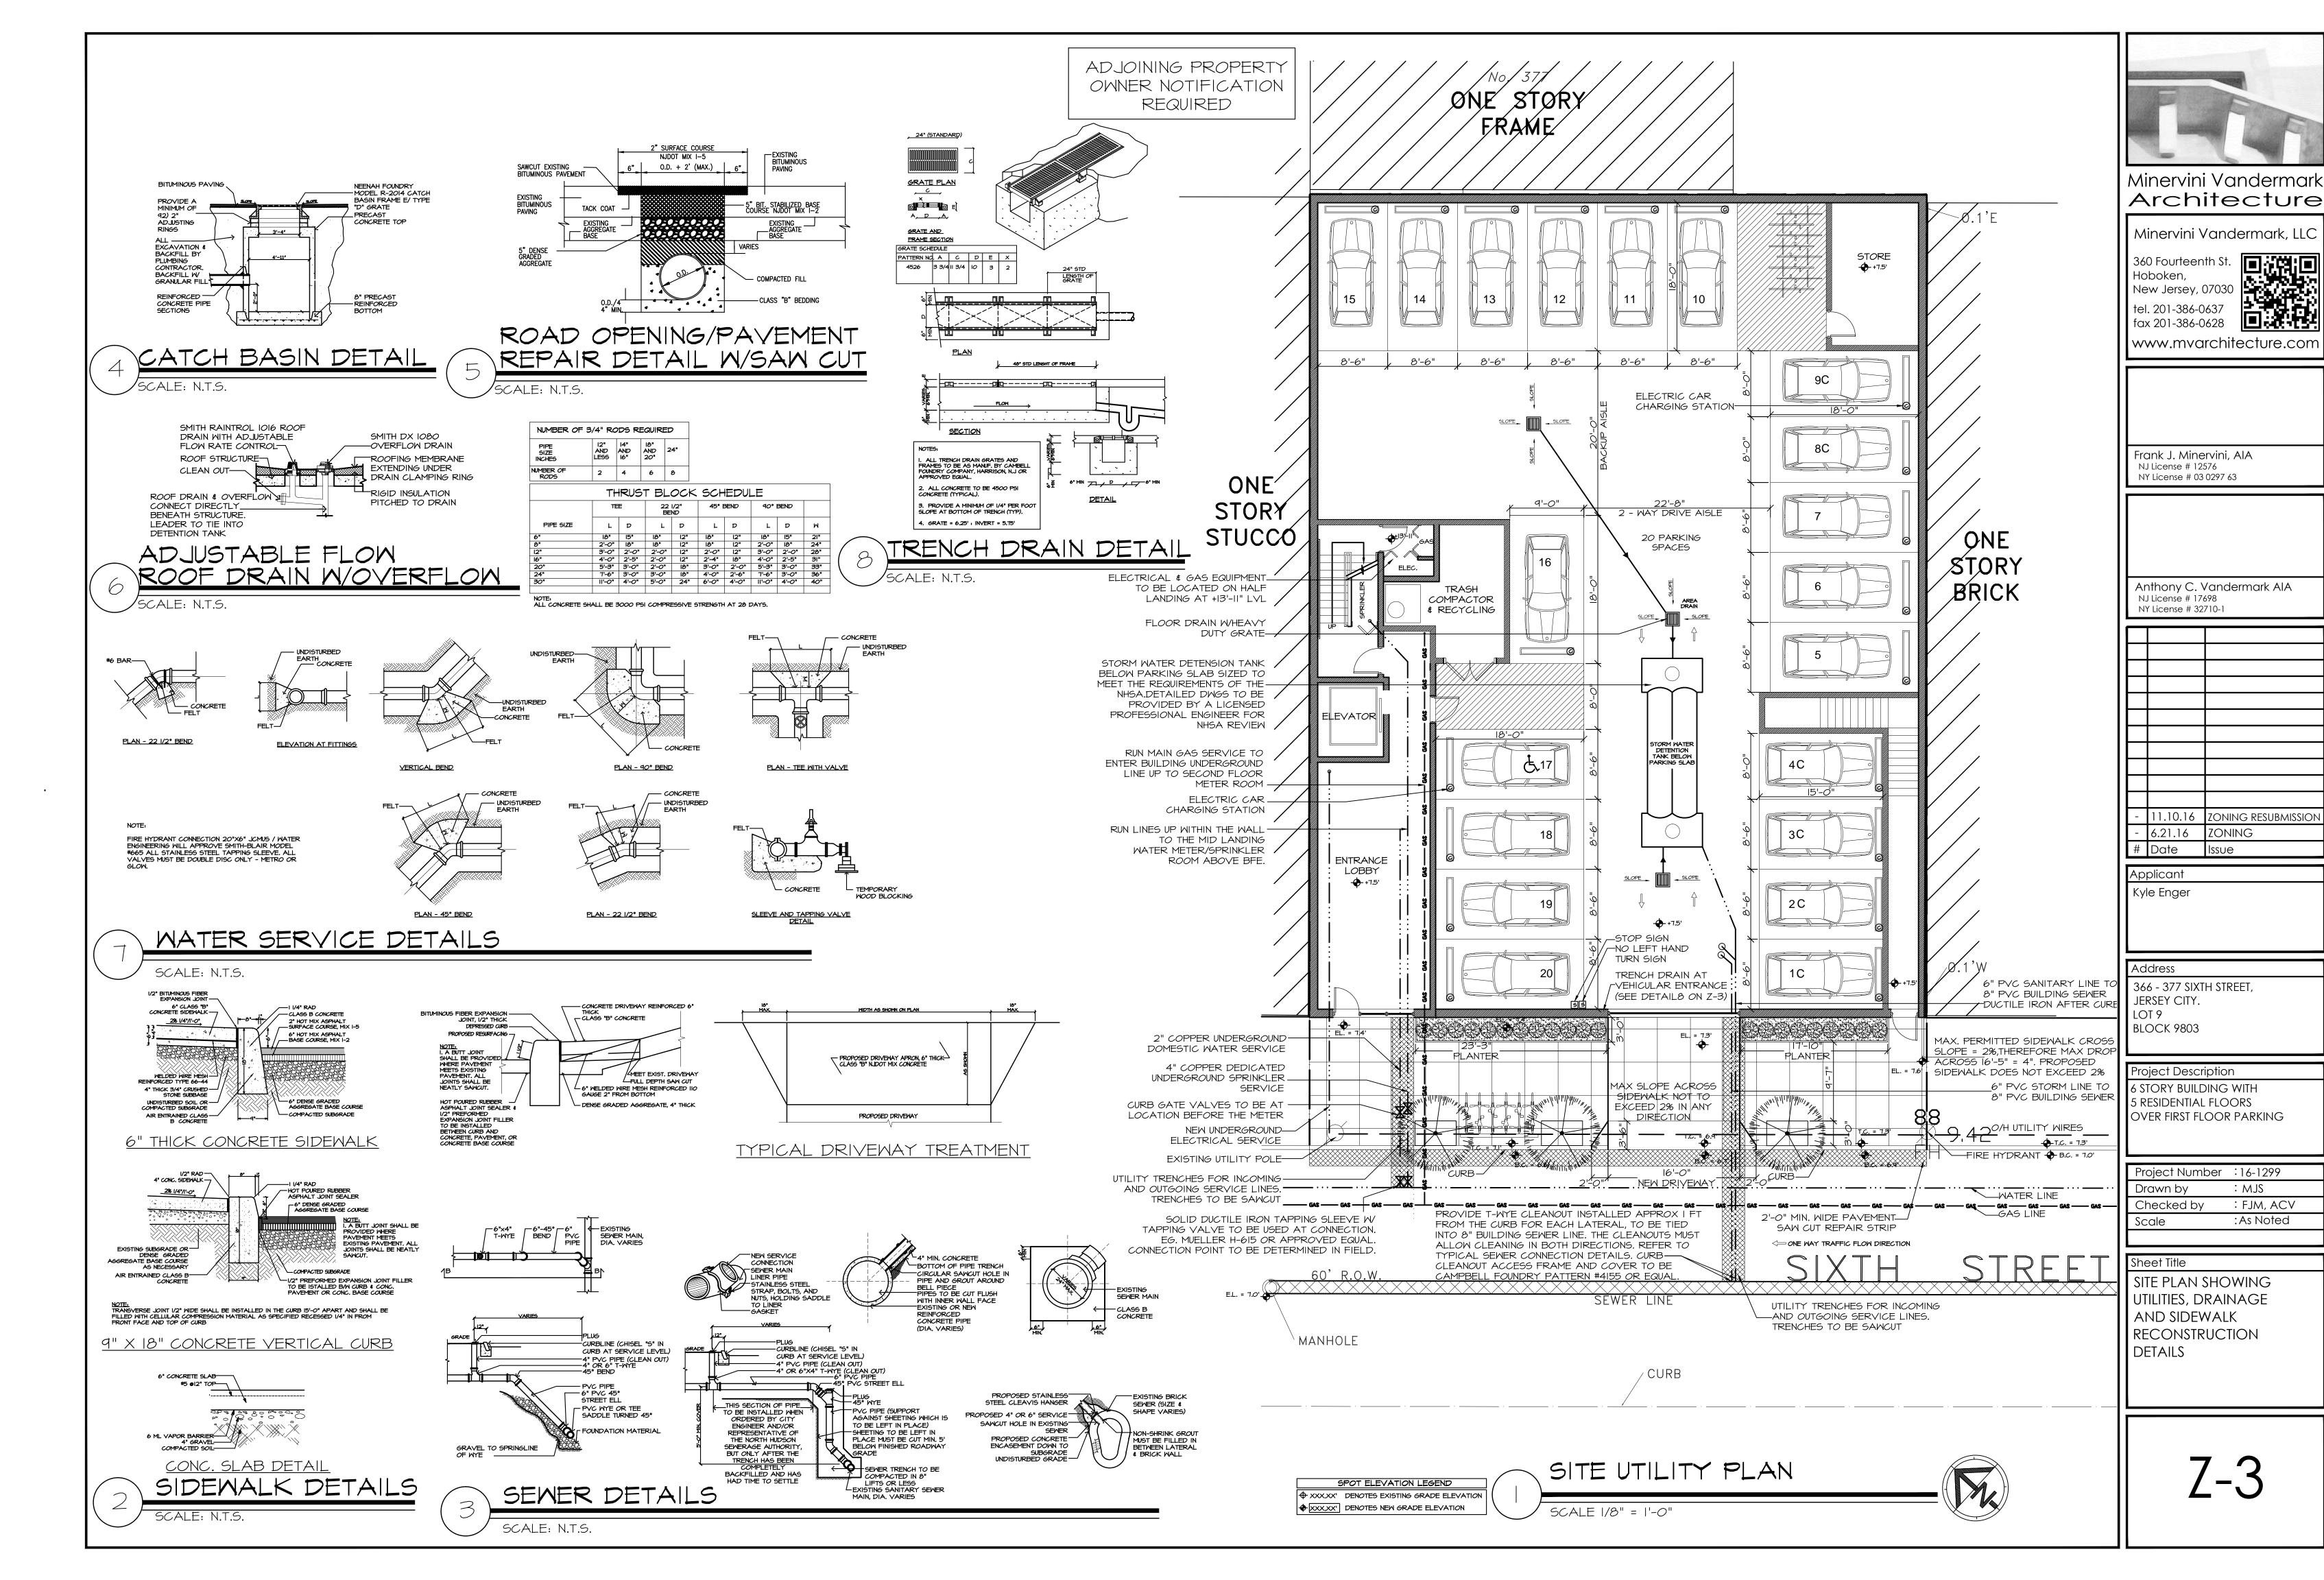

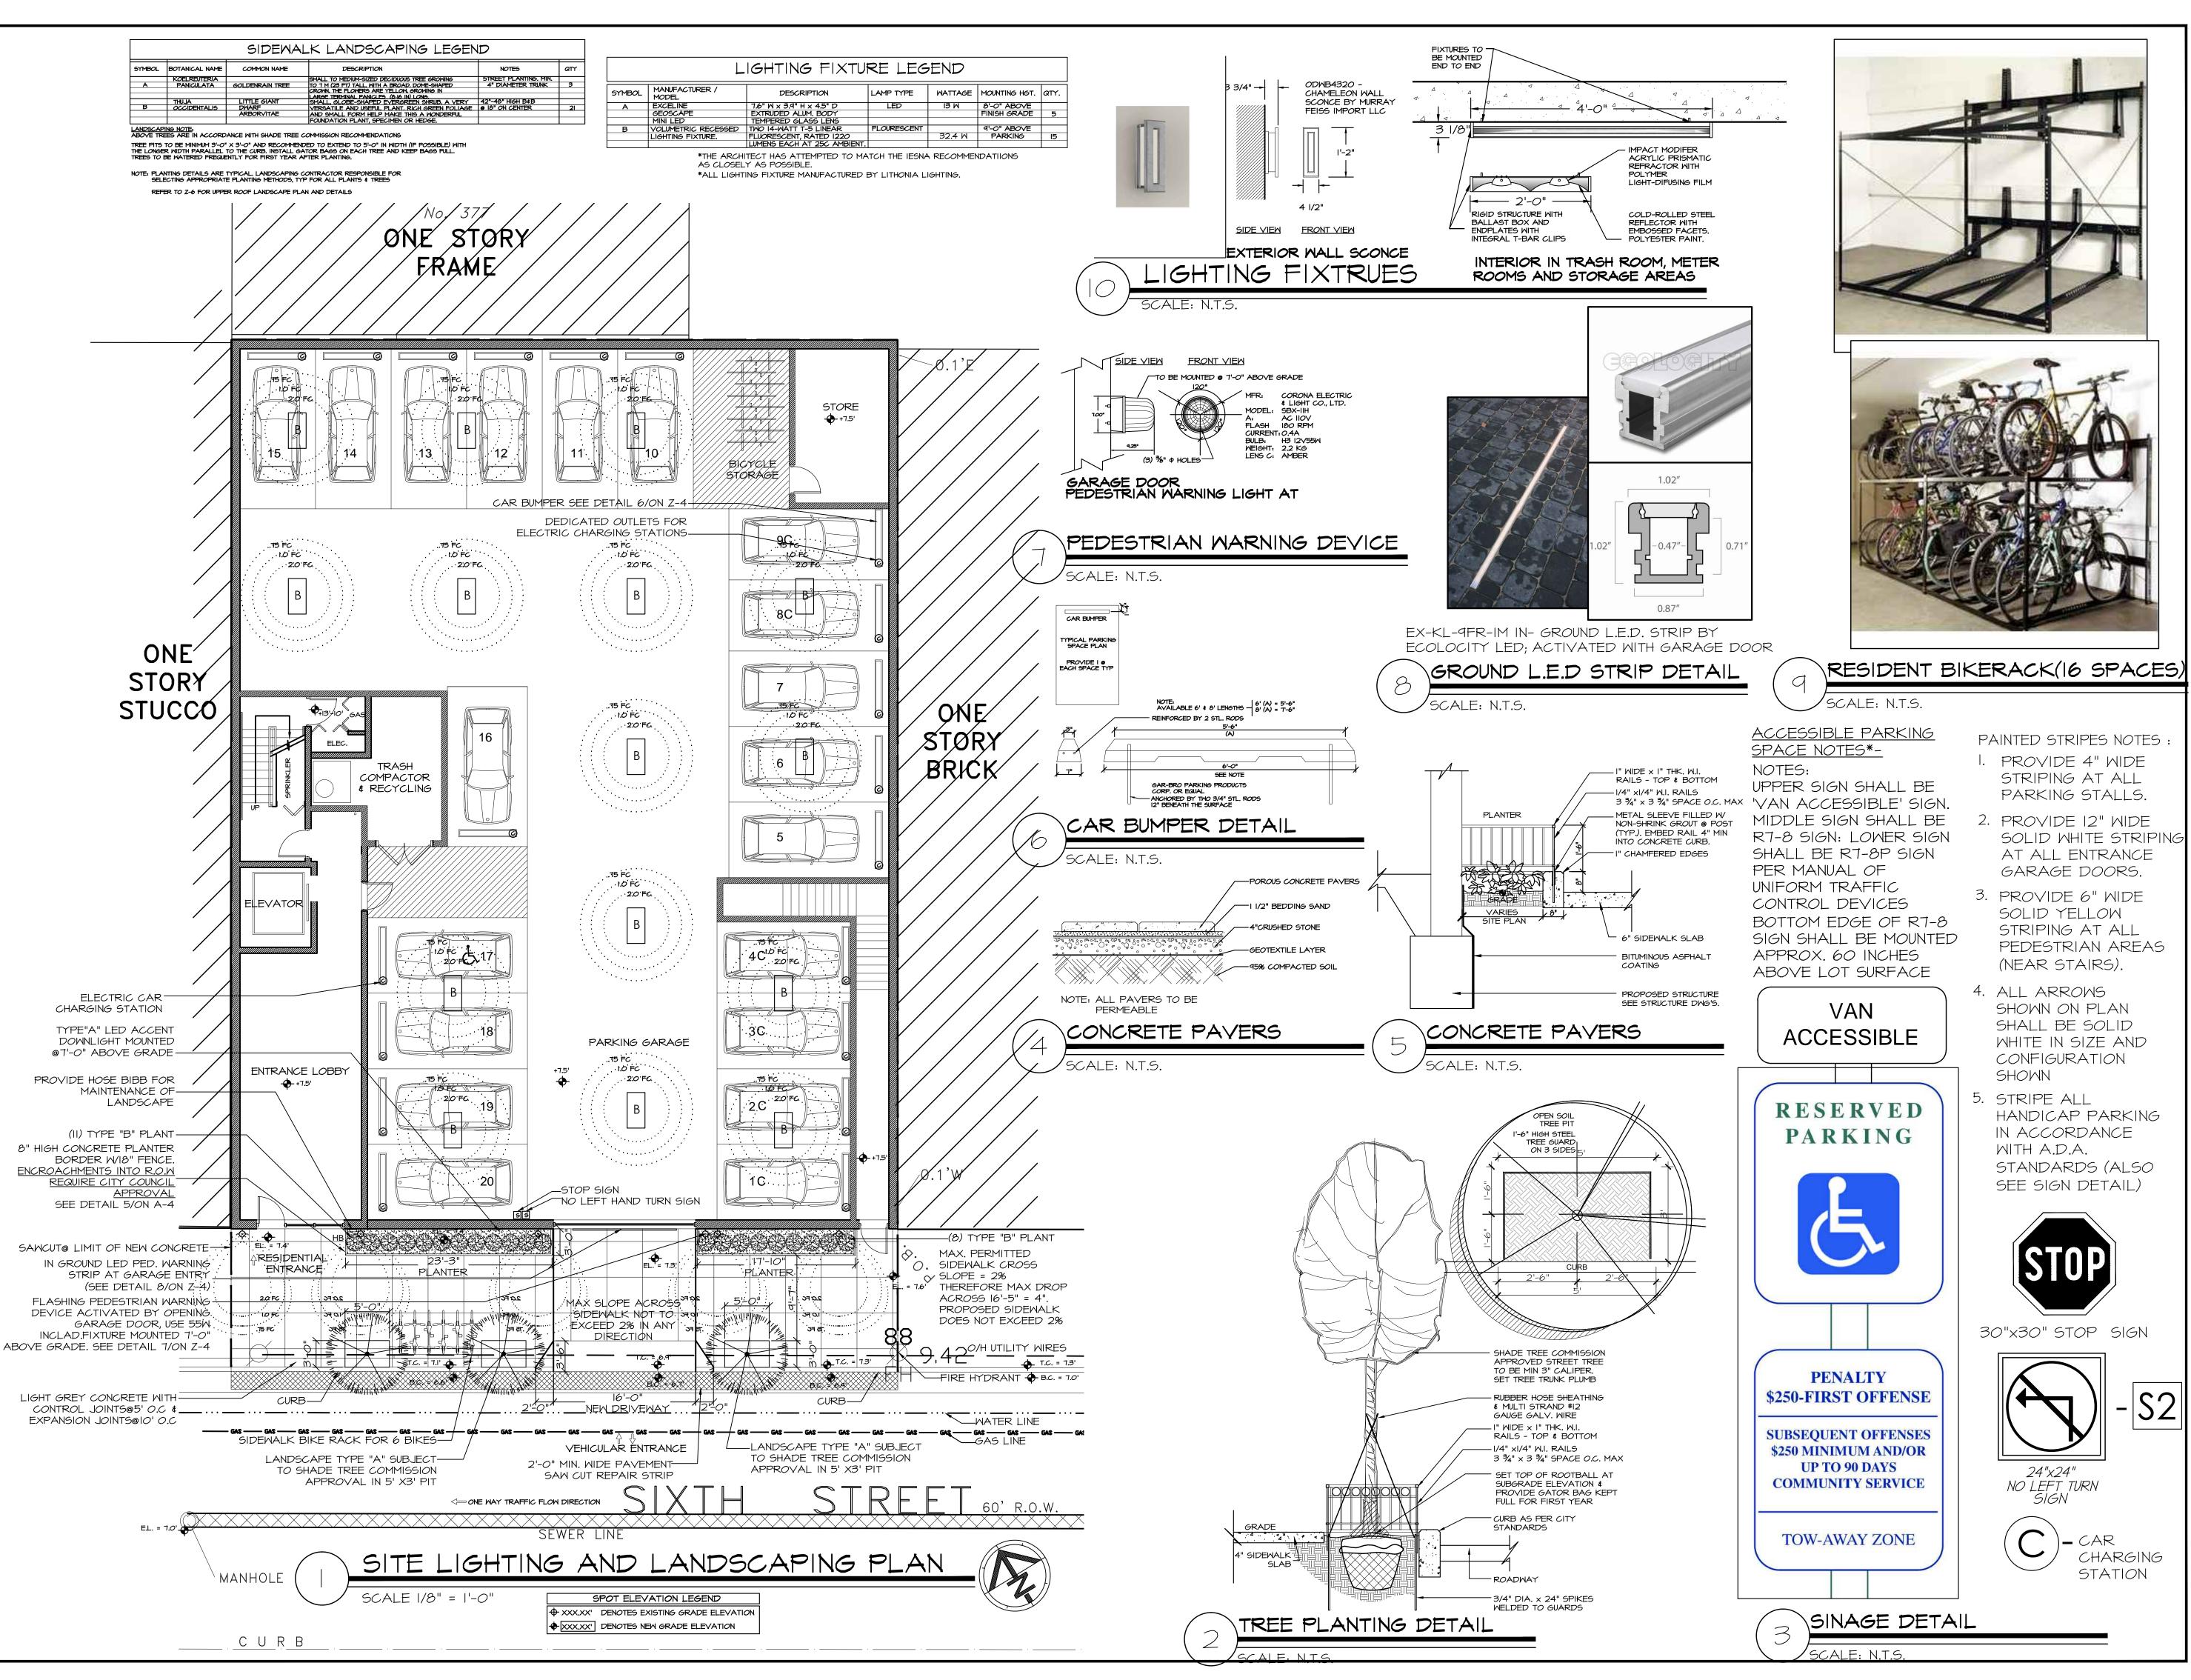







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Anthony C. Vandermark AIA NJ License # 17698 NY License # 32710-1

	F			
DAINTED CEDIDEC MATEC	lΓ			
PAINTED STRIPES NOTES :				
I. PROVIDE 4" WIDE				
STRIPING AT ALL				
PARKING STALLS.				
2. PROVIDE I2" WIDE				
SOLID WHITE STRIPING				
AT ALL ENTRANCE				
GARAGE DOORS.		-	11.10.16	ZONING RESUBMISSION
3. PROVIDE 6" WIDE		-	6.21.16	ZONING
J. I NO VIDE O MIDE	ΙГ	11	_	

Address

LOT 9

JERSEY CITY.

BLOCK 9803

366 - 377 SIXTH STREET,

Project Description

6 STORY BUILDING WITH

OVER FIRST FLOOR PARKING

Project Number : 16-1299

SITE PLAN SHOWING

LIGHTING AND

: MJS

: FJM, ACV

:As Noted

5 RESIDENTIAL FLOORS


Date SOLID YELLOW STRIPING AT ALL **Applicant** PEDESTRIAN AREAS Kyle Enger (NEAR STAIRS).

4. ALL ARROWS SHOWN ON PLAN SHALL BE SOLID WHITE IN SIZE AND CONFIGURATION SHOWN

STRIPE ALL HANDICAP PARKING IN ACCORDANCE MITH A.D.A. STANDARDS (ALSO SEE SIGN DETAIL)



30"x30" STOP SIGN

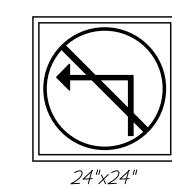

NO LEFT TURN SIGN

CAR CHARGING STATION


LANDSCAPING


Drawn by

Sheet Title

Scale

Checked by

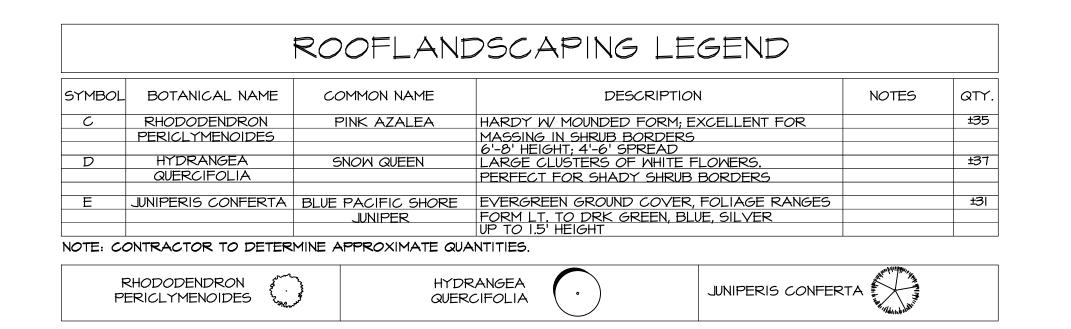

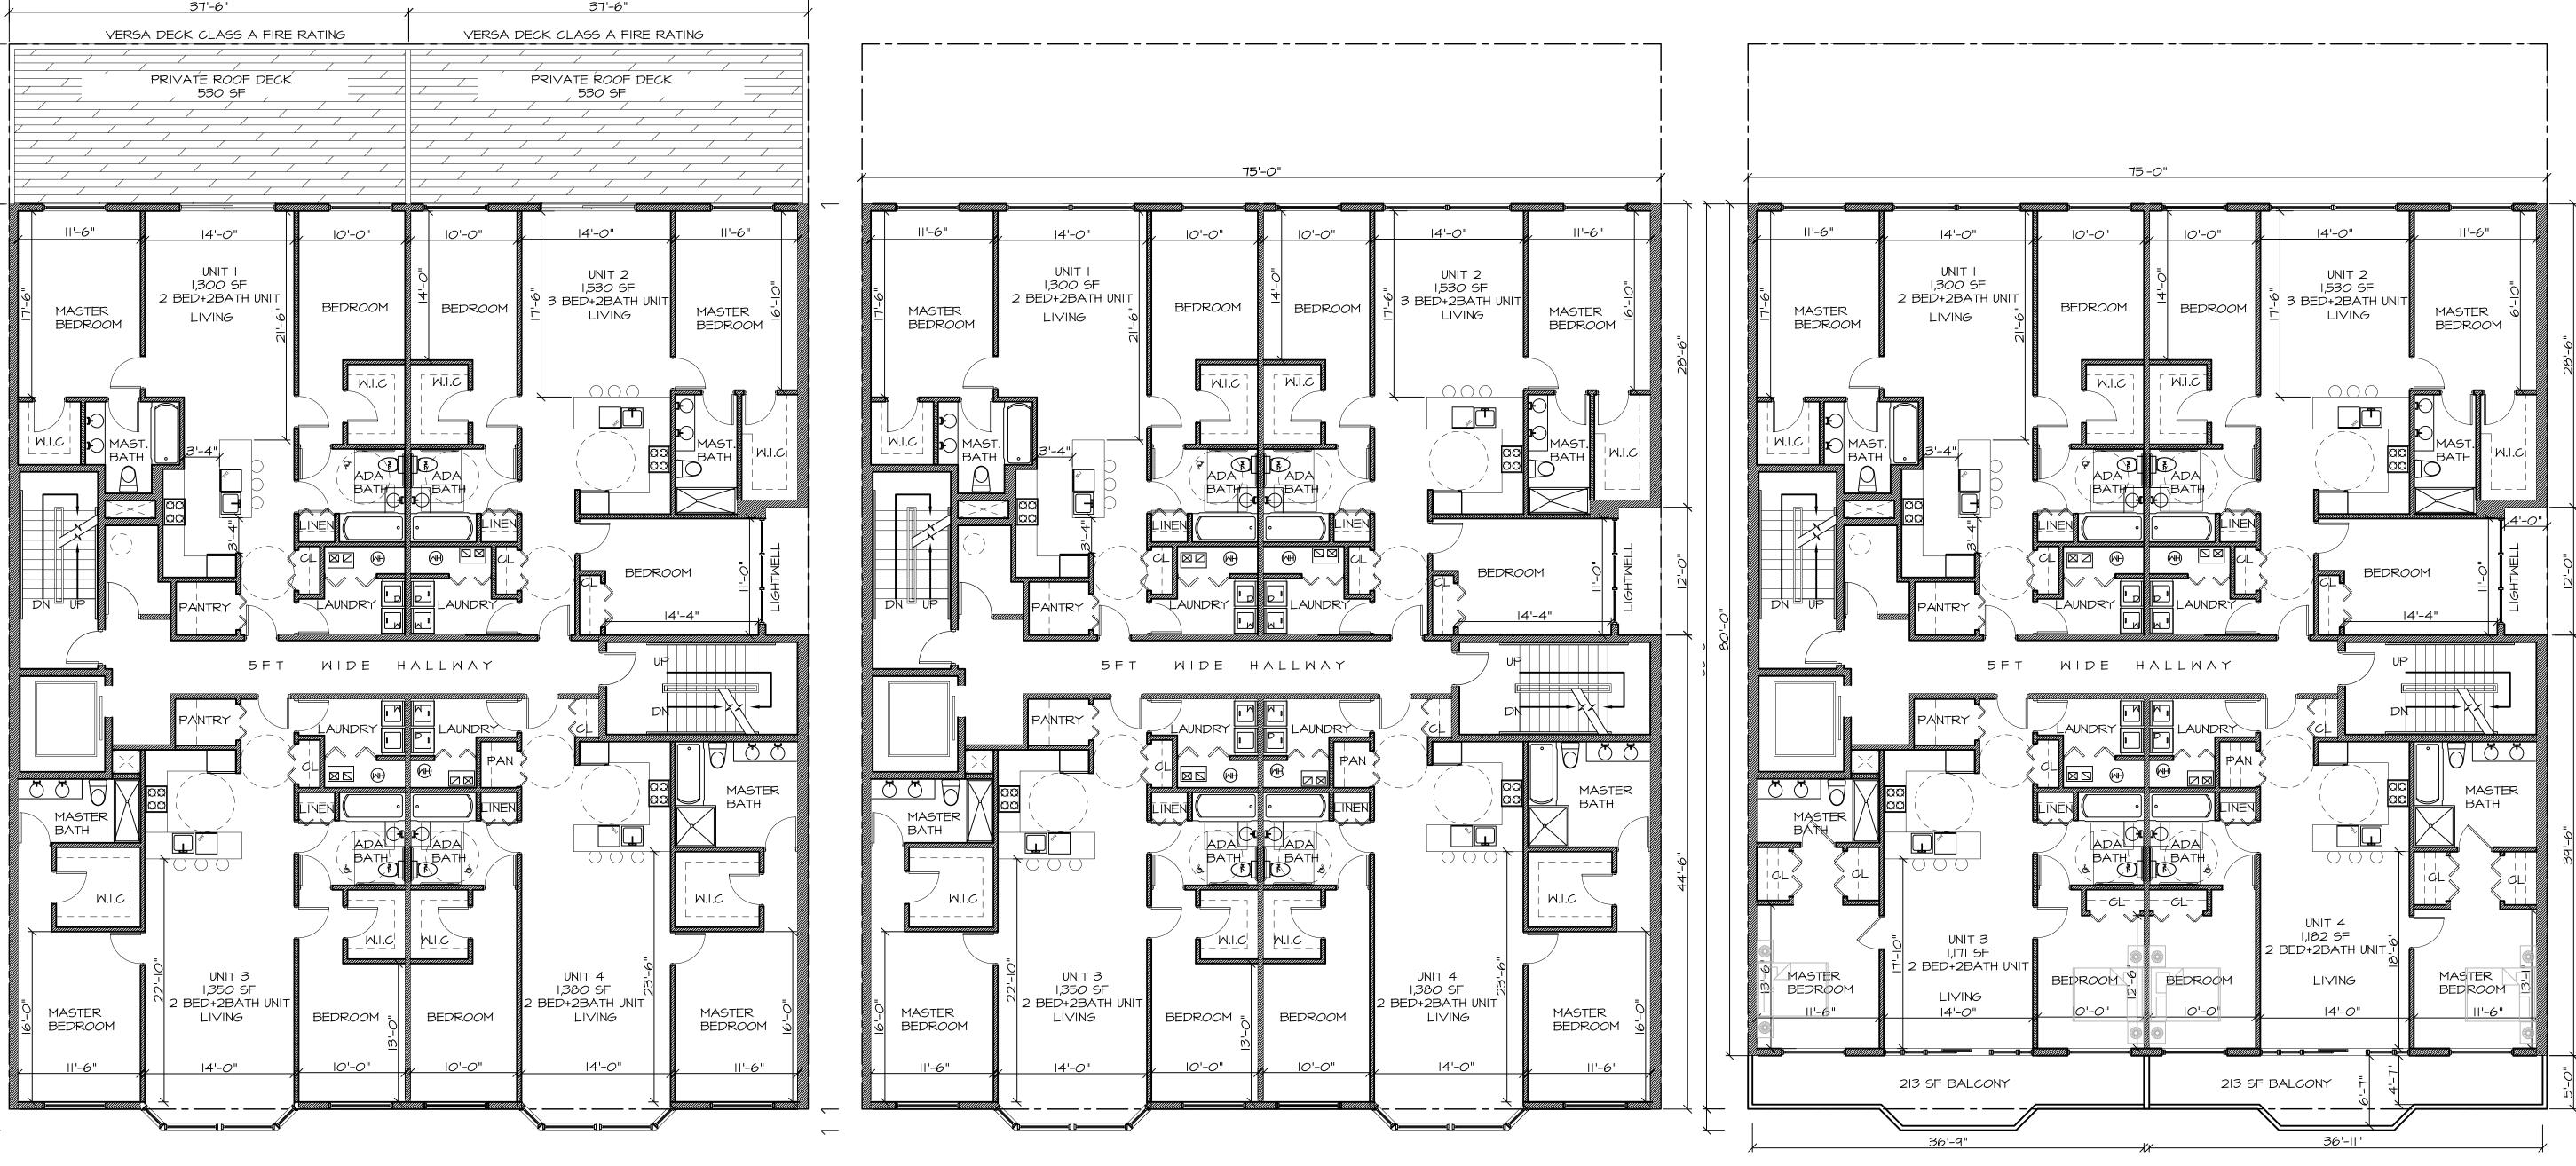




SCALE 1/8" = 1'-0"


3RD-5TH FLOOR PLAN

SCALE 1/8" = 1'-0"

6TH FLOOR PLAN

SCALE 1/8" = 1'-0"

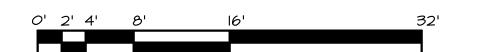


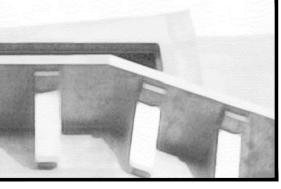

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Anthony C. Vandermark AIA NJ License # 17698 NY License # 32710-1

- 11.10.16 Zoning resubmission - 6.21.16 # Date ZONING

Applicant Kyle Enger

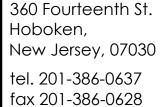
Address 366 - 377 SIXTH STREET, JERSEY CITY. LOT 9 BLOCK 9803

Project Description 6 STORY BUILDING WITH 5 RESIDENTIAL FLOORS OVER FIRST FLOOR PARKING

Project Number : 16-1299 Drawn by : MJS Checked by : FJM, ACV :As Noted

Sheet Title

2ND FLOOR PLAN 3RD - 5TH FLOOR PLAN 6TH FLOOR PLAN

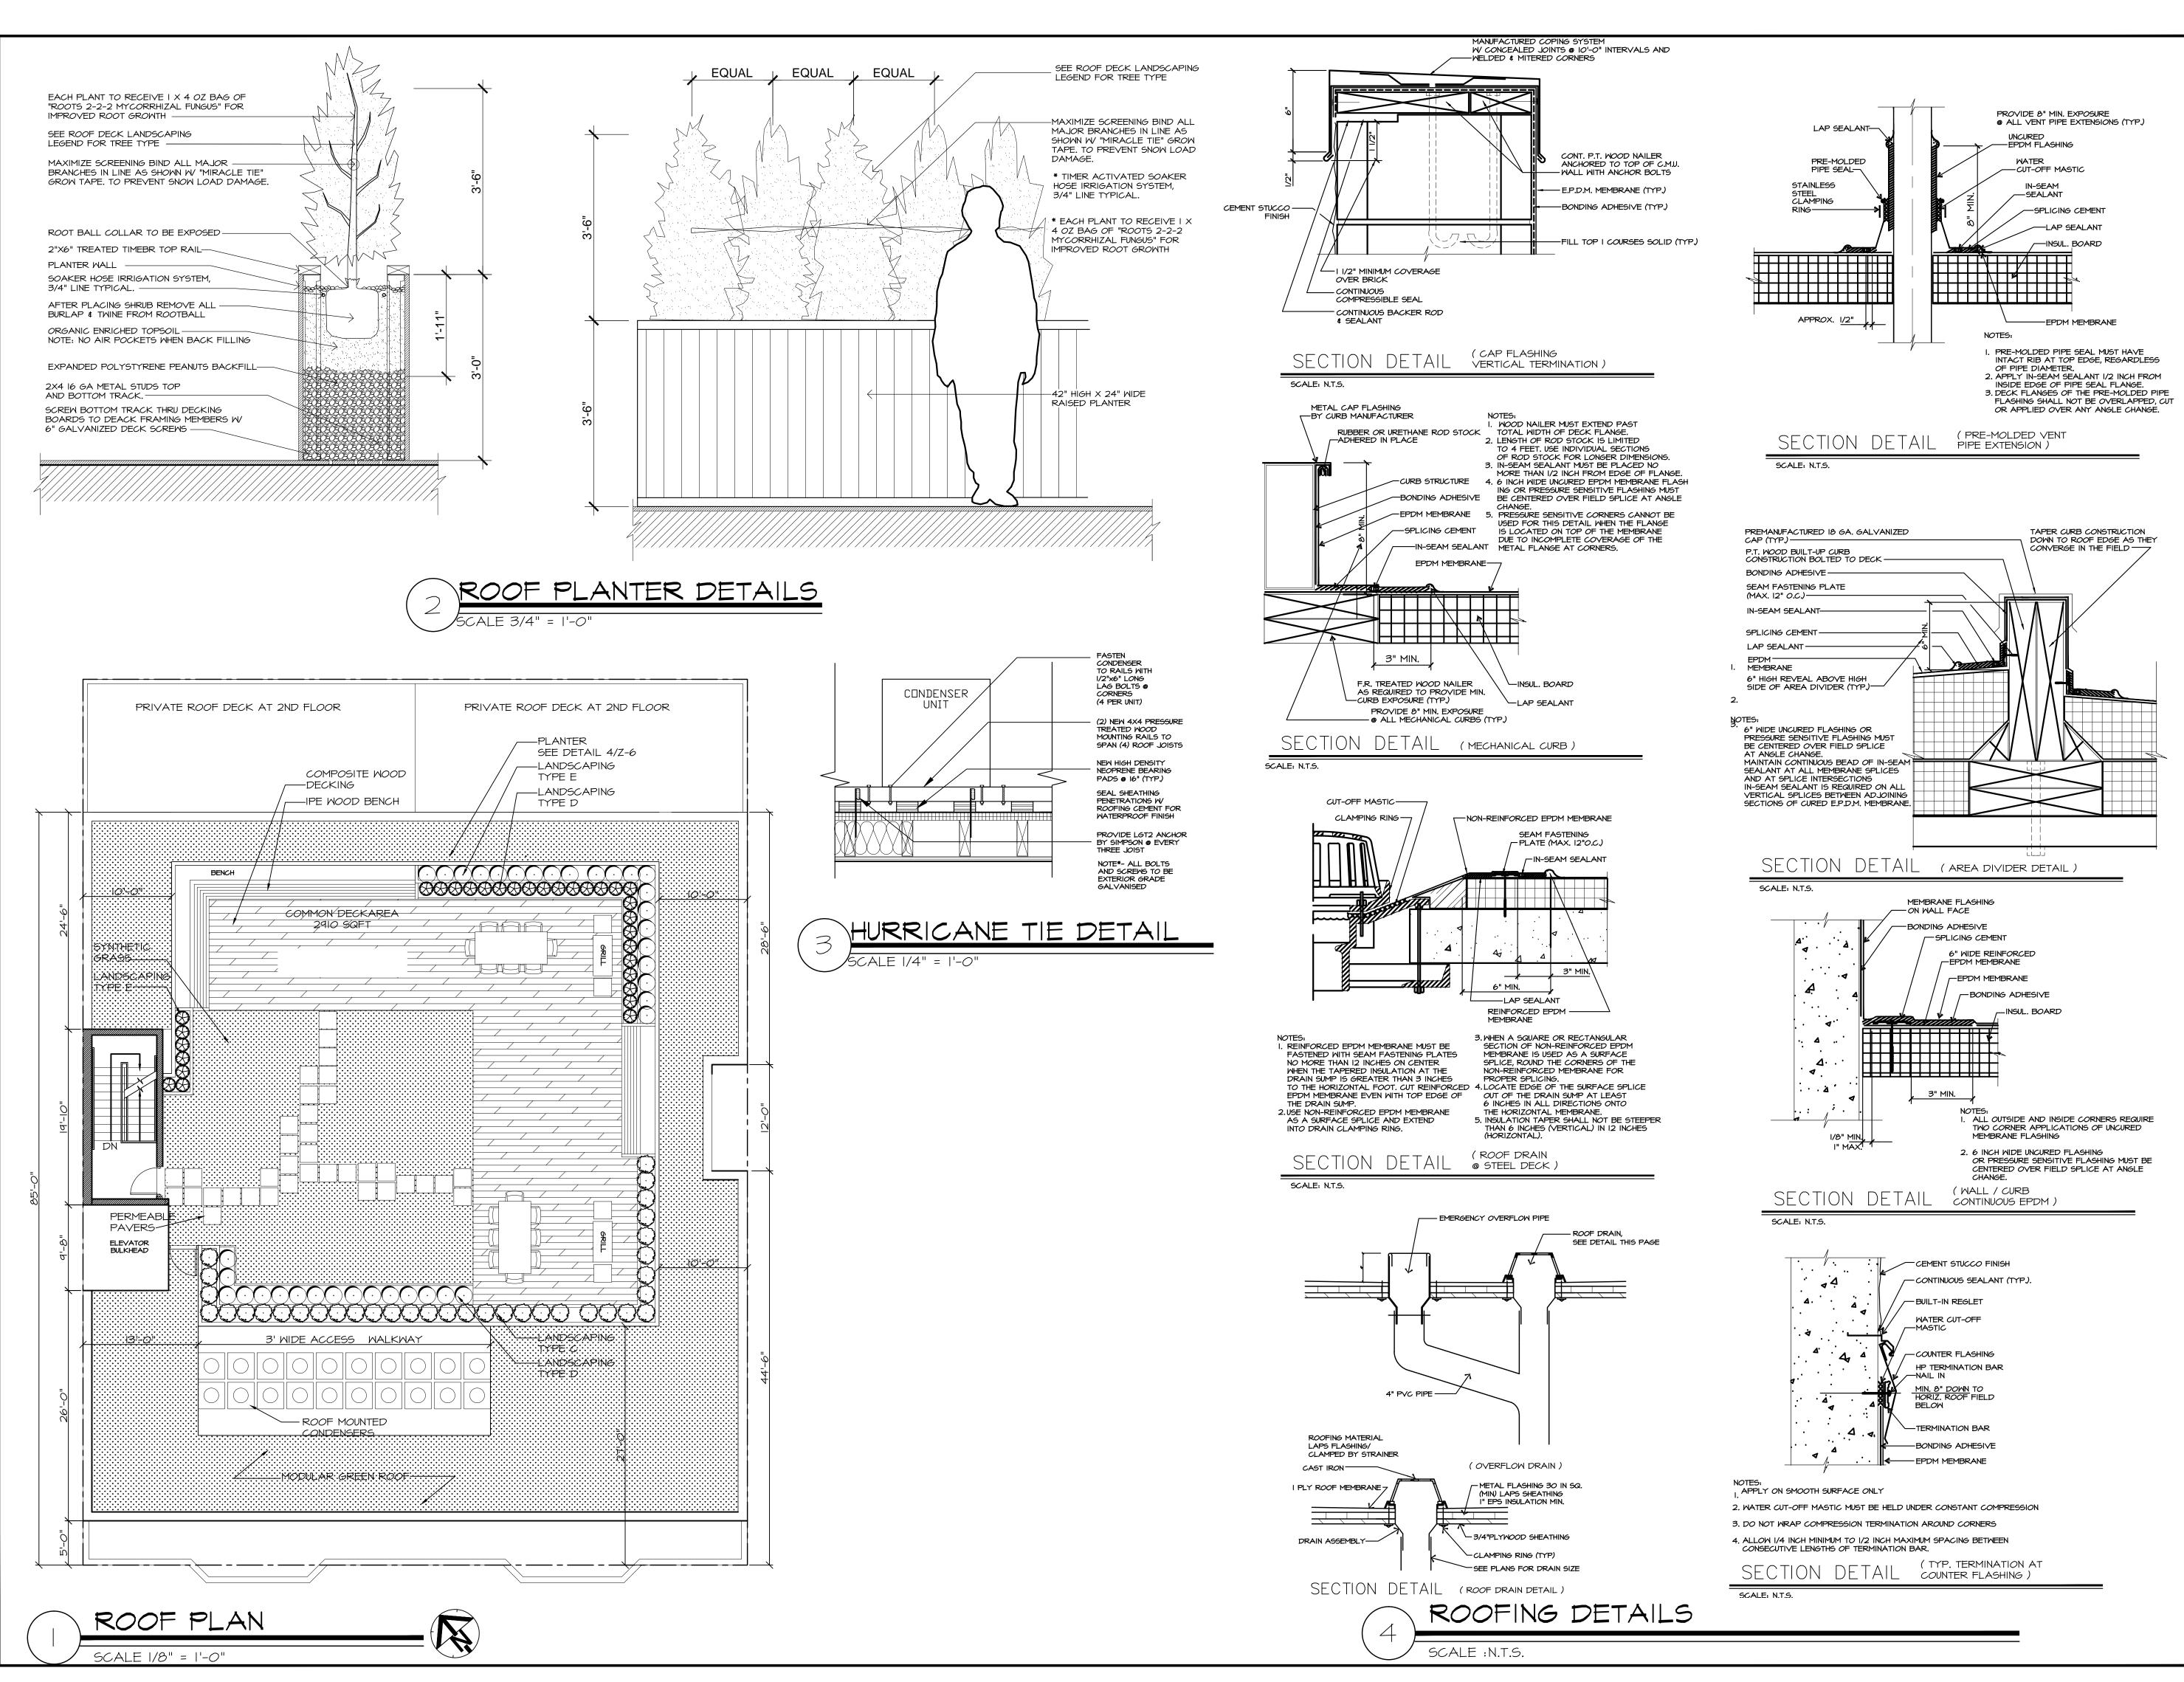

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11.10.16 ZONING RESUBMISSION - 6.21.16 ZONING # Date

Applicant Kyle Enger

Address

366 - 377 SIXTH STREET. JERSEY CITY. LOT 9 BLOCK 9803

Project Description 6 STORY BUILDING WITH

5 RESIDENTIAL FLOORS

OVER FIRST FLOOR PARKING Project Number : 16-1299

: MJS

: FJM, ACV

:As Noted


Scale Sheet Title

Drawn by

Checked by

ROOF PLAN, ROOFING

AND DECKING DETAILS

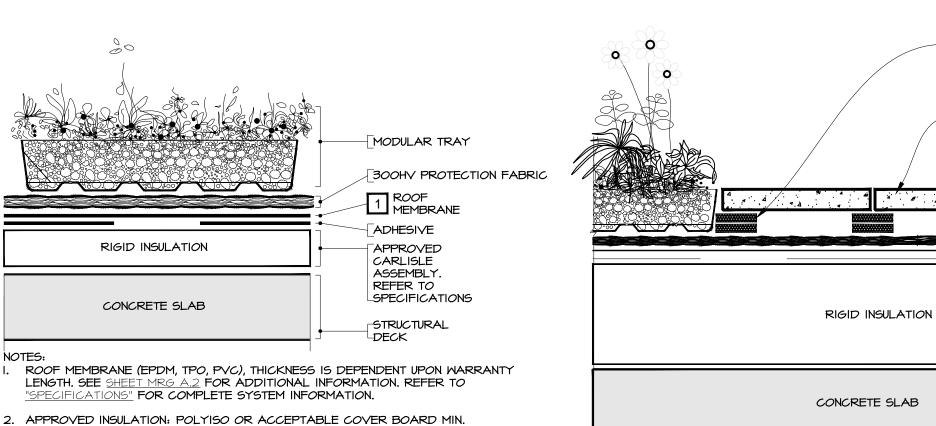

HORIZONTAL TRANSITION TILE/PAVERS

I. EXPANDED OR EXTRUDED POLYSTYRENE BOARDS WITH MINIMUM DENSITY OF 2 POUNDS PER CUBIC FOOT (32 KILOGRAM PER CUBIC METER) OR WITH COMPRESSIVE STRENGTH: 25 PSI (POUNDS PER SQUARE INCH) / 17577 KILOGRAM/METER2.


RUBBER PEDESTAL,


ADJUST HEIGHT AS

NEEDED 1

CONCRETE PAVER

2. IN LIEU OF CONCRETE PAVERS, USE STONE BALLAST, IO-15 POUNDS PER SQUARE FOOT (48.8 - 73.2 KILOGRAM/METER2) OVER 300HV PROTECTION FABRIC.

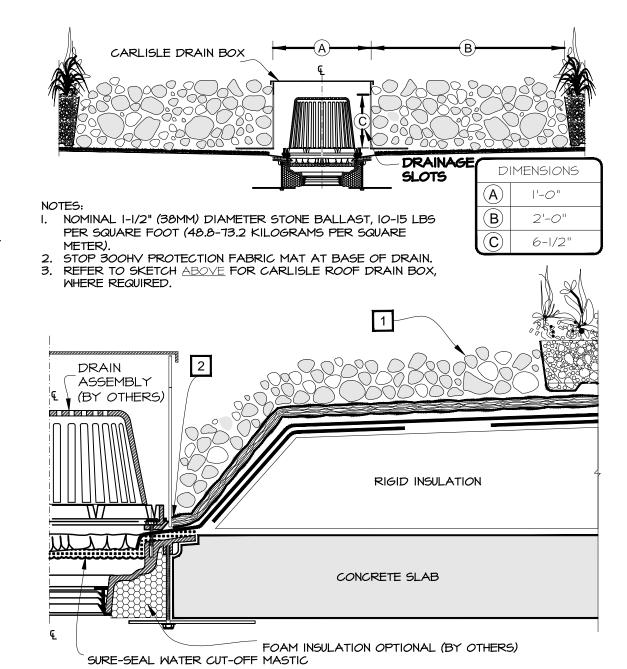

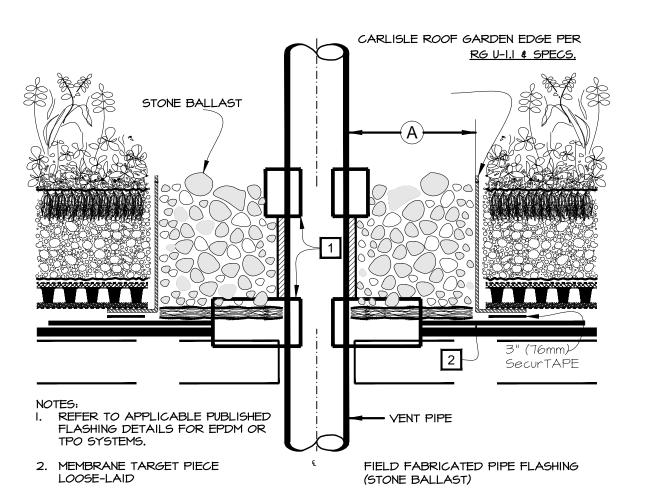

COMPRESSIVE STRENGTH 25 POUNDS PER SQUARE INCH [172 KPa (Kilopascals) /

POLYSTYRENE INSULATION

IRMA → INSULATED ROOF MEMBRANE ASSEMBLY

○ → SEE NOTE(S)

17577 Kilogram/meter²). REFER TO SPECS FOR ADDITIONAL INFORMATION.

NOTE: PROVIDE CARLISLE MODULAR ROOF GARDEN LINERS OR EQUAL.


CARLISLE GROWTH
MEDIA

MEDIA MiraDRAIN 64 DRAINAGE


■RB■ → REINFORCED POLYPROPYLENE)


MICOUR BARRIER (40-MIL NON-

300HV PROTECTION

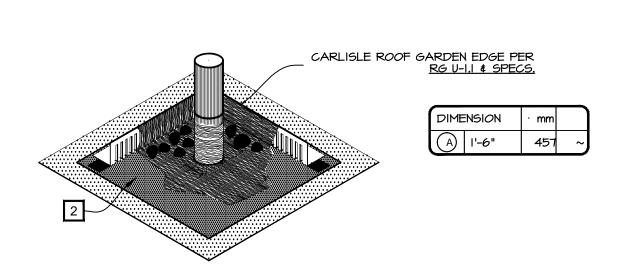

CARLISLE MODULAR GREEN ROOF TRAY DETAILS

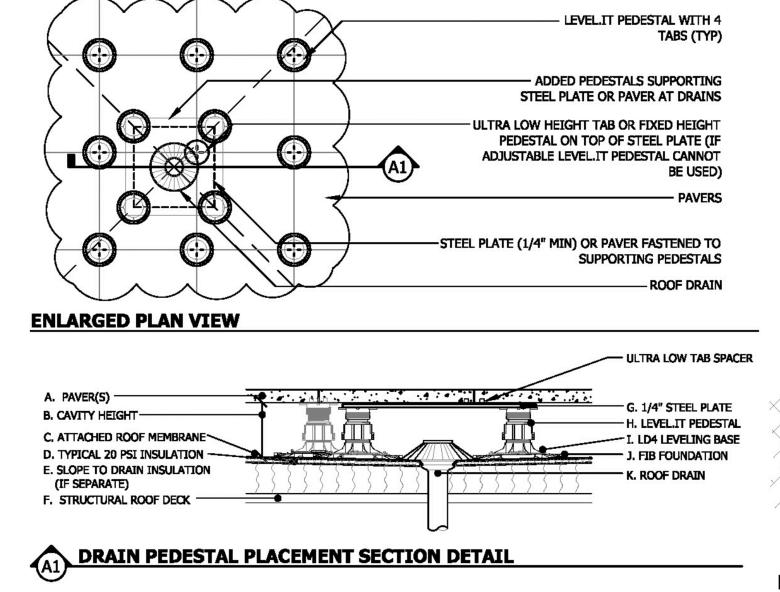

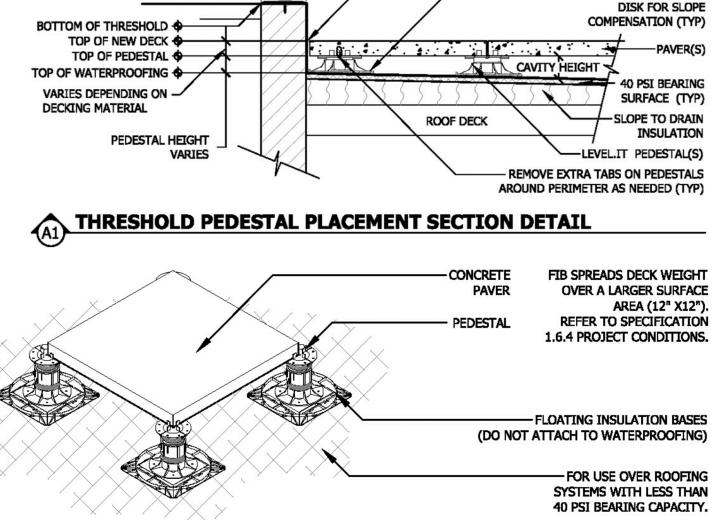


PEDESTALS ON FIBs (FLOATING INSULATION BASES)

THRESHOLD HEIGHT VARIES

BISON PEDESTAL ROOF DECKING DTL.

SCALE: 1/8" = 1'-0"

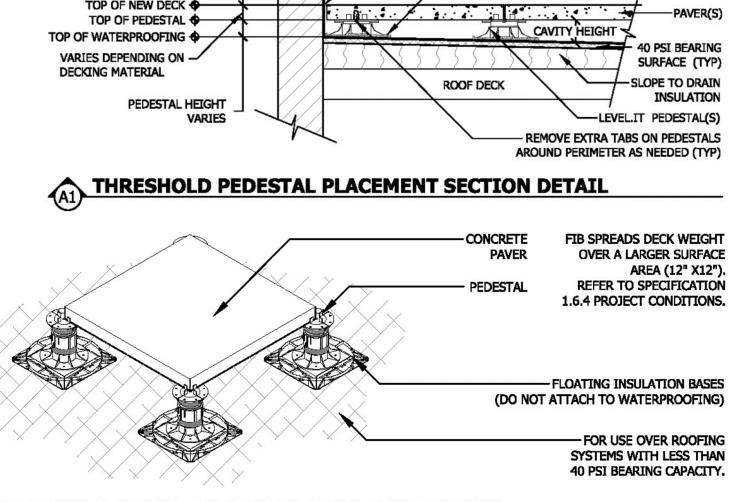

GREEN ROOF PLANT ESTABLISHMENT PERIOD

THE ESTABLISHMENT PERIOD FOR GREEN ROOF IS THE FIRST FULL GROWING SEASON FOLLOWING PLANTING. CAREFUL WATERING AND ATTENTION TO THE GREEN ROOF SYSTEM IS KEY TO MAINTAINING A HEALTHY ROOF AND HEADING-OFF FUTURE MAINTENANCE DIFFICULTIES.

INSTALLATION SEASON ESTABLISHMENT PERIOD

FALL / WINTER: SPRING & SUMMER OF THE FOLLOWING YEAR UNTIL ONSET OF COOL FALL WEATHER SUMMER: THROUGH SUMMER OF THE FOLLOWING YEAR

DURING ESTABLISHMENT PERIOD, CHECK GREEN ROOF FREQUENTLY TO ENSURE THAT THE AUTOMATIC IRRIGATION SYSTEM (IF INSTALLED) IS FUNCTIONING PROPERLY, TO HAND-WATER (IF NECESSARY), AND TO WEED OUT ANY INVASIVE PLANTS. DOCUMENT ALL MAINTENANCE ACTIVITIES.

RECOMMENDED GREEN ROOF WATERING SCHEDULE

SEDUM CUTTINGS

- OVERHEAD WATERING TWICE DAILY FOR THE FIRST
- TMO (2) MEEKS
- ONCE A DAY FOR THE THIRD WEEK
- ONCE A WEEK FOR THE NEXT FOUR (4) WEEKS
- FOR THE DURATION OF THE ESTABLISH. PERIOD AS-NEEDED, CHECK AT LEAST WEEKLY. SEDUM PLUGS, TILES, AND PRE-GROWN GREEN ROOF TRAYS
- ONCE A WEEK FOR THE FIRST FOUR (4) WEEKS
- FOR THE DURATION OF THE ESTABLISH. PERIOD: AS-NEEDED, CHECK AT LEAST WEEKLY.

ONGOING MAINTENANCE ACTIVITIES

A GREEN ROOF SHOULD BE INSPECTED AT LEAST ONCE PER MONTH DURING THE GROWING SEASON TO ASSESS VEGETATIVE COVER AND TO LOOK FOR LEAKS OR DRAINAGE PROBLEMS. DOCUMENT ALL MAINTENANCE ACTIVITIES.


- REMOVE ALL DEBRIS THAT CAN BLOCK DRAINAGE AND SMOTHER GREEN ROOF PLANTS.
- HAND WEED, DO NOT DIG OR USE POINTED TOOLS WHERE THERE IS POTENTIAL TO HARM THE ROOT BARRIER OR WATERPROOF MEMBRANE.
- INSPECT ROOF DRAINS, DRAINAGE PATHS, SCUPPERS, AND GUTTERS TO ENSURE THEY ARE NOT OVERGROWN.
- REPLACE PLANTS & GROWING MEDIA AS NECESSARY.
- CHECK MOISTURE LEVELS AND WATER AS NECESSARY PER INSTALLERS RECOMMENDATIONS BUT <u>DO NOT OVER WATER</u>.
- REGULARLY CHECK IRRIGATION SYSTEM AND WINTERIZE YEARLY
- AVOID THE USE OF HERBICIDES, INSECTICIDES, AND FUNGICIDES.
- DO NOT POWER WASH

* INFORMATION PROVIDED BY:

COLUMBIA GREEN TECHNOLOGIES - INFO@COLUMBIA-GREEN.COM -WWW.COLUMBIA-GREEN.COM

GREEN ROOF MAINTENANCE SCHEDULE

BOTTOM OF FASCIA BOARD MAY BE CUT ABOVE SUBSTRATE TO ALLOW WATER TO ESCAPE. FASCIA BOARD MUST FULLY CONTAIN PAVERS, AND MUST TIE BACK INTO A BUILDING WALL OR

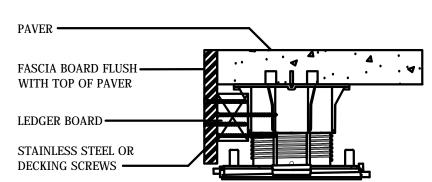


BISON PAVER PEDESTAL DTL.

SCALE: 1/8" = 1'-0"


BOTTOM OF METAL CONTAINMENT MAY BE BENT OR CUT ABOVE SUBSTRATE TO ALLOW WATER TO ESCAPE. METAL CONTAINMENT MUST FULLY CONTAIN PAVERS, AND MUST TIE BACK IN TO A BUILDING WALL OR

AT PERIMETER (TYP)

LD4 BASE LEVELER

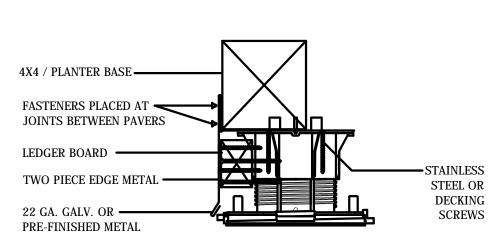

BISON ROOF PLANTER BASE DTL.

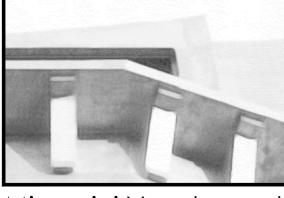

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- 11.10.16 ZONING RESUBMISSION ZONING - 6.21.16 # Date

Applicant Kyle Enger

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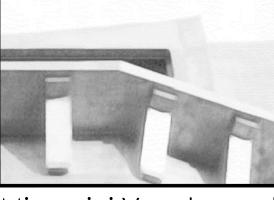
Sheet Title

BISON PEDESTAL GREEN ROOF DETAILS









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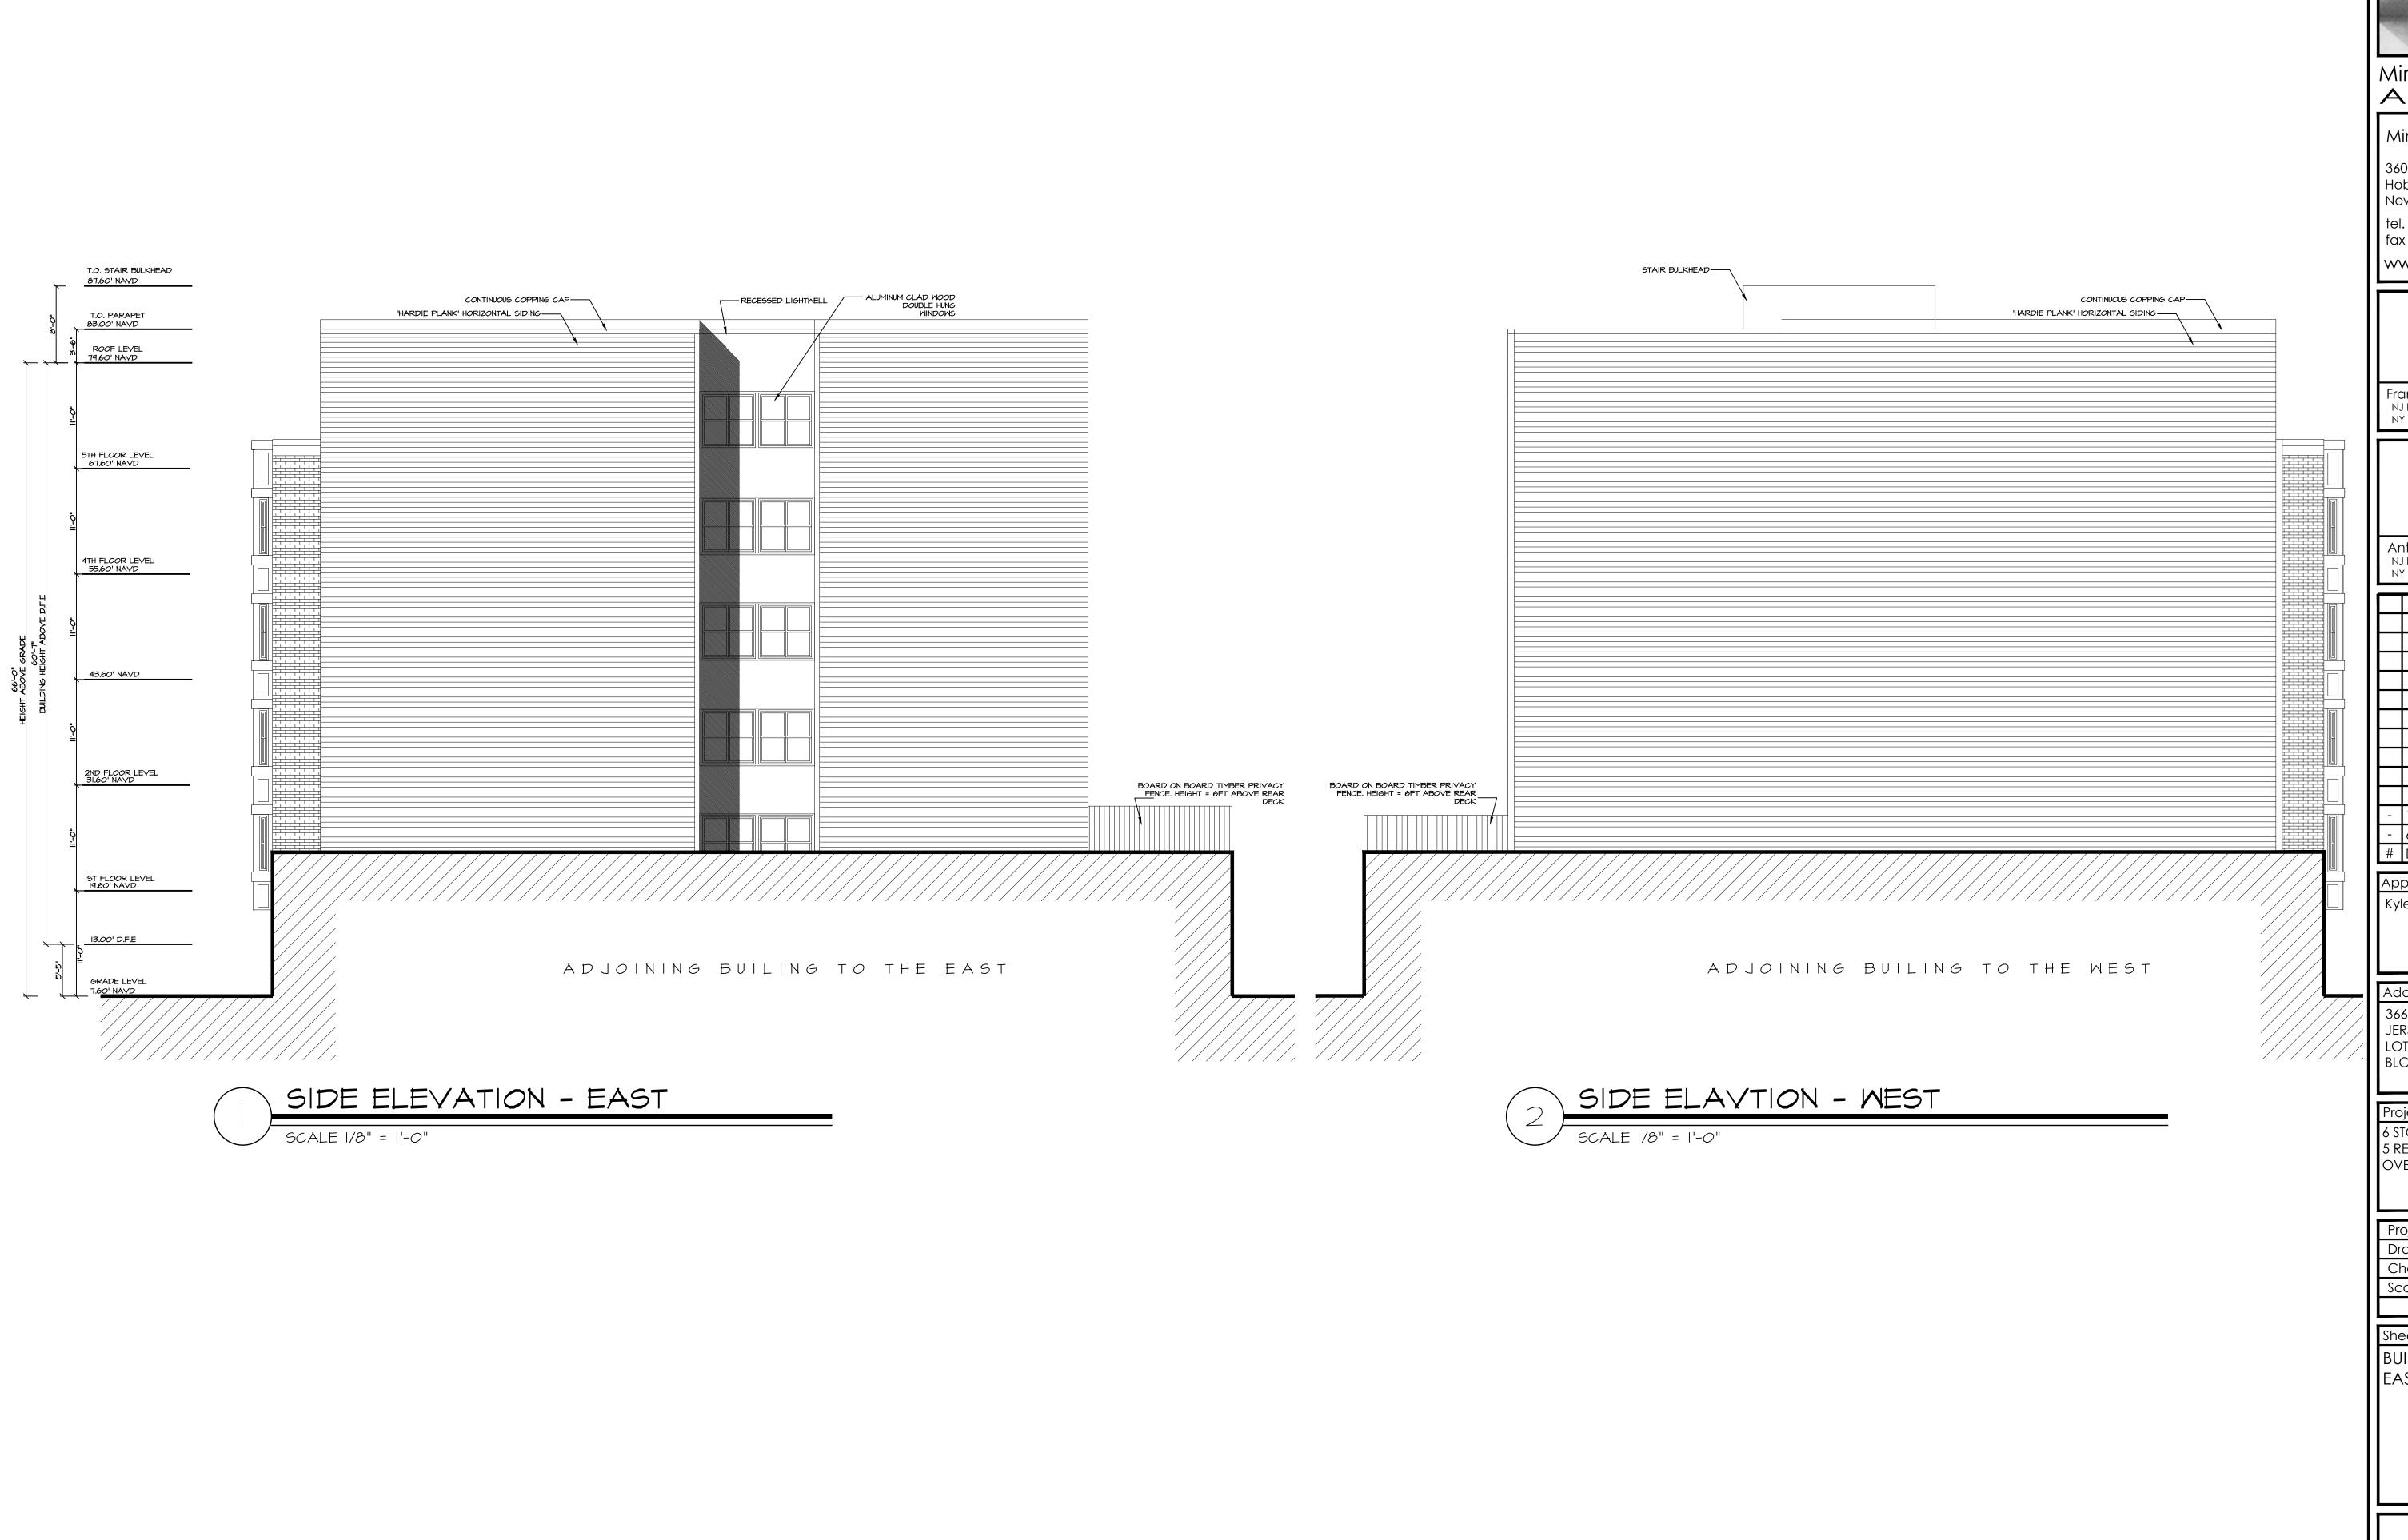
Project Description 6 STORY BUILDING WITH 5 RESIDENTIAL FLOORS


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Sheet Title

BUILDING ELEVATIONS FRONT & REAR





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-	6.21.16	ZONING
#	Date	Issue
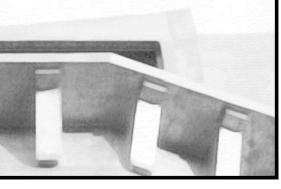
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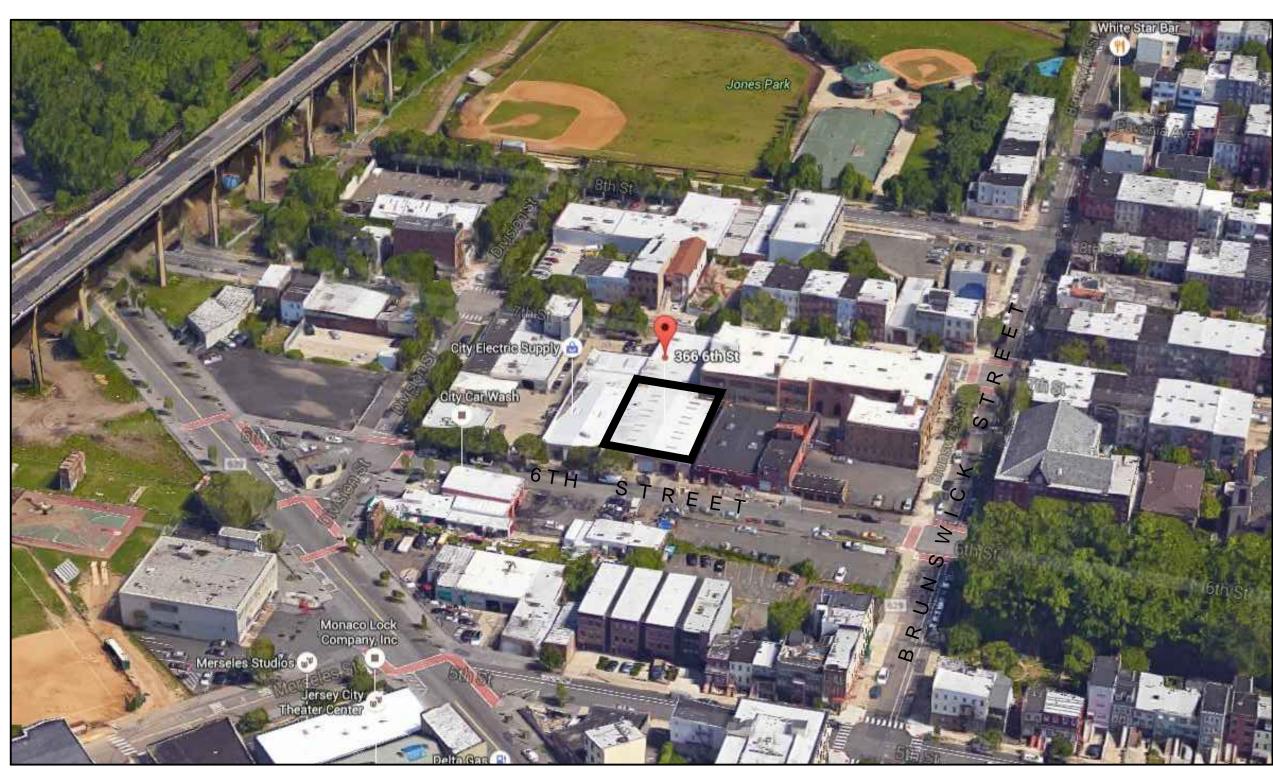
١	Project Number	:16-1299
ı	Drawn by	: MJS
ı	Checked by	: FJM, ACV
ı	Scale	:As Noted
- 1		

Sheet Title

BUILDING ELEVATIONS EAST AND WEST



SCALE: N.T.S



BIRD'S EYE VIEW SCALE: N.T.S

6TH STREET ELEVATION LOOKING WEST SCALE: N.T.S





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<u> </u>				
_	11.10.16	ZONING RESUBMISSIC		
_	6.21.16	ZONING		
#	Date	Issue		

Applicant

Kyle Enger

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JERSEY CITY.
LOT 9
BLOCK 9803

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SITE PHOTOS